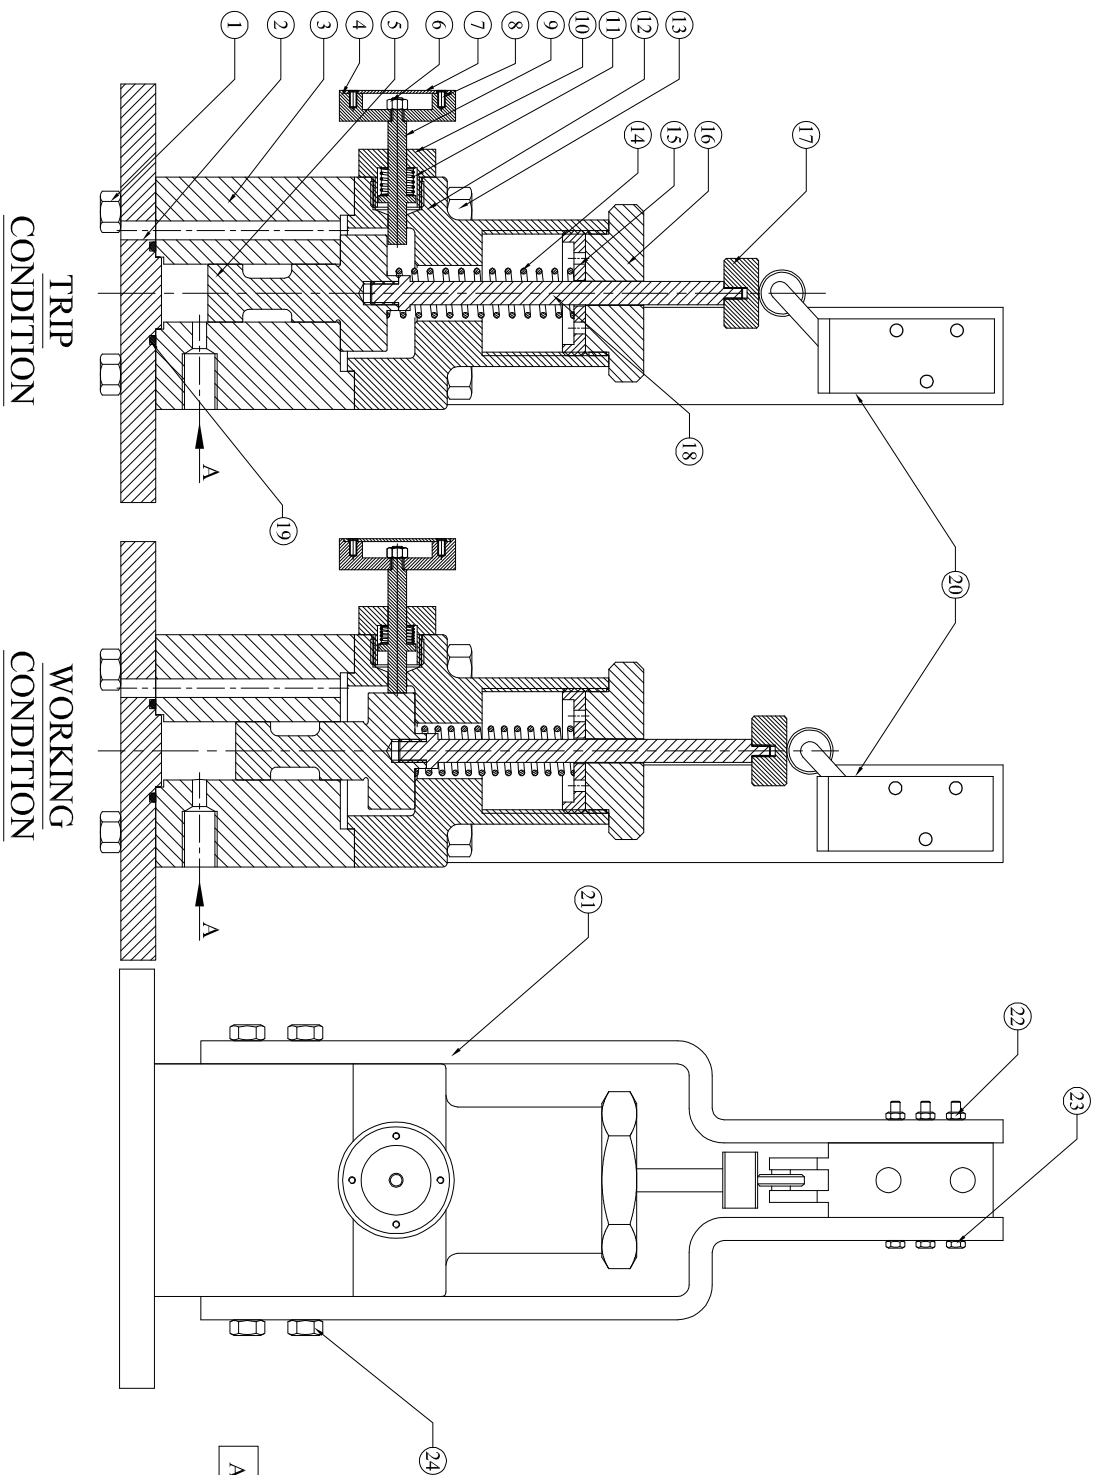


**LIST OF ILLUSTRATIONS, P&ID'S & SUB-SUPPLIER'S MANUALS /
CATALOGUES / DRAWINGS.**

Description	Illustration No.	Drawing No.
General Arrangement of TG Set	01	PT-AS-7963
Turbine Sectional Arrangement	02	PT-AS-7970
Dump Valve Assembly	03	PT-AS-7541
Manual Trip Assembly	04	PT-AS-4422
Over Speed Trip Assembly	05	PT-AS-3500
Journal & Thrust Bearing Assembly	06	PT-AS-2307
Oil Cooler	07	PT-PRA-1135
Oil Filter	08	PT-PRA-1134
Clearances & Fitting details	09	PT-AS-9889
Lifting Arrangement	10	PT-AS-7969

LIST OF P & ID'S	
Description	Drawing No.
Legends	PT-LGD-GC5M
P & ID for Oil System	PT-PI- GC5M/01
P & ID for Steam System	PT-PI- GC5M/02
P & ID for Water System	PT-PI- GC5M/03
P & ID for Steam Drain & Sealing System	PT-PI- GC5M/04
SLD for Vibration Monitoring	PT-PI- GC5M/05
SUB-SUPPLIERS INSTRUCTION MANUAL/CATALOGUES/ DRAWINGS	
Gear Box / Reduction Gear Box Manual	
Main Stop Valve and Control Valve (Butterfly Valve) Manual	
Control Valve System Manual	
Emergency Oil Pump	
Auxiliary Oil Pump (AOP)	
Solenoid Valve	
High Speed coupling	
Low Speed Coupling	



DESCRIPTION		
SL No.	COMPONENT NAME	QTY.
1	M12 x 25 BOLT	4 Nos
2	BOTTOM PLATE	1 No
3	DUMP VALVE BODY	1 No
4	L.P. TRIP KNOB	1 No
5	PLUNGER	1 No
6	M5 LOCK NUT	1 No
7	NAME PLATE (PULL TO RESET)	1 No
8	M3 x 6 CSK SCREWS	4 Nos
9	L.P. TRIP CATCH SPINDLE	1 No
10	L.P. TRIP CATCH COVER	1 No
11	L.P. TRIP CATCH SPRING	1 No
12	L.P. TRIP COVER	1 No
13	M12 x 50 BOLT	4 Nos
14	DUMP VALVE SPRING	1 No
15	L.P. TRIP SPRING ADJUSTING SCREW	1 No
16	L.P. TRIP COVER NUT	1 No
17	TOP PLATE	1 No
18	TRIP SPINDLE	1 No
19	O' RING (43 OD x 37 ID x 3 Thk.)	1 No
20	SPOOL VALVE	1 No
21	SPOOL VALVE CLAMP	2 Nos
22	M4 HEXAGONAL NUT	3 Nos
23	M4 x 60 L BOLT	3 Nos
24	M8 x 20 L BOLT	6 Nos

A LUBE OIL INLET

ILLUSTRATION NUMBER-03

TITLE: DUMP VALVE ASSEMBLY

Max/WattTM DRG. No. PT-AS-7541

DO NOT SCALE, IF IN DOUBT ASK

SECTION - 'AA'

PLAN VIEW

SL.No.	DESCRIPTION	QTY
1	STEAM END PEDESTAL COVER	1 No.
2	OIL FEED CONNECTION	1 No.
3	'O' RING	1 No.
4	MANUAL TRIP BODY	1 No.
5	M10 ALLEN SCREW	2 Nos.
6	NAME PLATE	1 No.
7	MANUAL TRIP HANDLE	1 No.
8	M12 NUT	1 No.

9	MANUAL TRIP VALVE	1 No.
10	M3 ALLEN SCREW	1 No.
11	MANUAL TRIP SPRING	1 No.
12	Ø6 BALL	1 No.
13	'O' RING	1 No.
14	¾" NUT & TAIL PIECE	1 No.
15	DRIVING FIT	1 No.
16	M10 ALLEN SCREW	2 Nos.

ILLUSTRATION NUMBER-04

TITLE: MANUAL TRIP ASSEMBLY

Max/Watt™

DRG. NO.
PT-AS-4422

DO NOT SCALE, IF IN DOUBT ASK

SECTION - 'AA'

PLAN VIEW

SL.No.	DESCRIPTION	QTY
1	STEAM END PEDESTAL COVER	1 No.
2	OIL FEED CONNECTION	1 No.
3	O-RING	1 No.
4	MANUAL TRIP BODY	1 No.
5	M10 ALLEN SCREW	2 Nos.
6	NAME PLATE	1 No.
7	MANUAL TRIP HANDLE	1 No.
8	M12 NUT	1 No.
9	MANUAL TRIP VALVE	1 No.
10	M3 ALLEN SCREW	1 No.
11	MANUAL TRIP SPRING	1 No.
12	Ø6 BALL	1 No.
13	O-RING	1 No.
14	¾" NUT & TAIL PIECE DRIVING FIT	1 No.
15	M10 ALLEN SCREW	2 Nos.

ILLUSTRATION NUMBER-04

TITLE: MANUAL TRIP ASSEMBLY

DRG. NO.

Max/Watt™

PT-AS-4422

DO NOT SCALE, IF IN DOUBT ASK

SECTION - 'AA'

PLAN VIEW

SL.No.	DESCRIPTION	QTY
1	STEAM END PEDESTAL COVER	1 No.
2	OIL FEED CONNECTION	1 No.
3	O-RING	1 No.
4	MANUAL TRIP BODY	1 No.
5	M10 ALLEN SCREW	2 Nos.
6	NAME PLATE	1 No.
7	MANUAL TRIP HANDLE	1 No.
8	M12 NUT	1 No.
9	MANUAL TRIP VALVE	1 No.
10	M3 ALLEN SCREW	1 No.
11	MANUAL TRIP SPRING	1 No.
12	Ø6 BALL	1 No.
13	O-RING	1 No.
14	¾" NUT & TAIL PIECE DRIVING FIT	1 No.
15	M10 ALLEN SCREW	2 Nos.

ILLUSTRATION NUMBER-04

TITLE: MANUAL TRIP ASSEMBLY

Max/Watt™

DRG. NO.
PT-AS-4422

DO NOT SCALE, IF IN DOUBT ASK

SL.No.	DESCRIPTION	QTY
1	STEAM END PEDESTAL COVER	1 No.
2	OIL FEED CONNECTION	1 No.
3	O-RING	1 No.
4	MANUAL TRIP BODY	1 No.
5	M10 ALLEN SCREW	2 Nos.
6	NAME PLATE	1 No.
7	MANUAL TRIP HANDLE	1 No.
8	M12 NUT	1 No.

SL.No.	DESCRIPTION	QTY
9	MANUAL TRIP VALVE	1 No.
10	M3 ALLEN SCREW	1 No.
11	MANUAL TRIP SPRING	1 No.
12	Ø6 BALL	1 No.
13	O-RING	1 No.
14	¾" NUT & TAIL PIECE	1 No.
15	DRIVING FIT	1 No.
16	M10 ALLEN SCREW	2 Nos.

PLAN VIEW

ILLUSTRATION NUMBER-04

TITLE: MANUAL TRIP ASSEMBLY

Max/Watt™

DRG. NO.
PT-AS-4422

DO NOT SCALE, IF IN DOUBT ASK

SL.No.	DESCRIPTION	QTY
--------	-------------	-----

1	STEAM END PEDESTAL COVER	1 No.
2	OIL FEED CONNECTION	1 No.
3	O-RING	1 No.
4	MANUAL TRIP BODY	1 No.
5	M10 ALLEN SCREW	2 Nos.
6	NAME PLATE	1 No.
7	MANUAL TRIP HANDLE	1 No.
8	M12 NUT	1 No.

PLAN VIEW

ILLUSTRATION NUMBER-04

TITLE: MANUAL TRIP ASSEMBLY

Max/Watt™

DRG. NO.
PT-AS-4422

DO NOT SCALE IF IN DOUBT ASK

DESCRIPTION

COMPONENT NO	COMPONENT NAME	QTY
1	OVER SPEED TRIP SPRING	1No.
2	OVER SPEED TRIP VALVE	1No.
3	OVER SPEED TRIP CAP	1No.
4	PIN (Ø3 x 9.5mm LENGTH)	2Nos.
5	OVER SPEED TRIP SHAFT	1No.


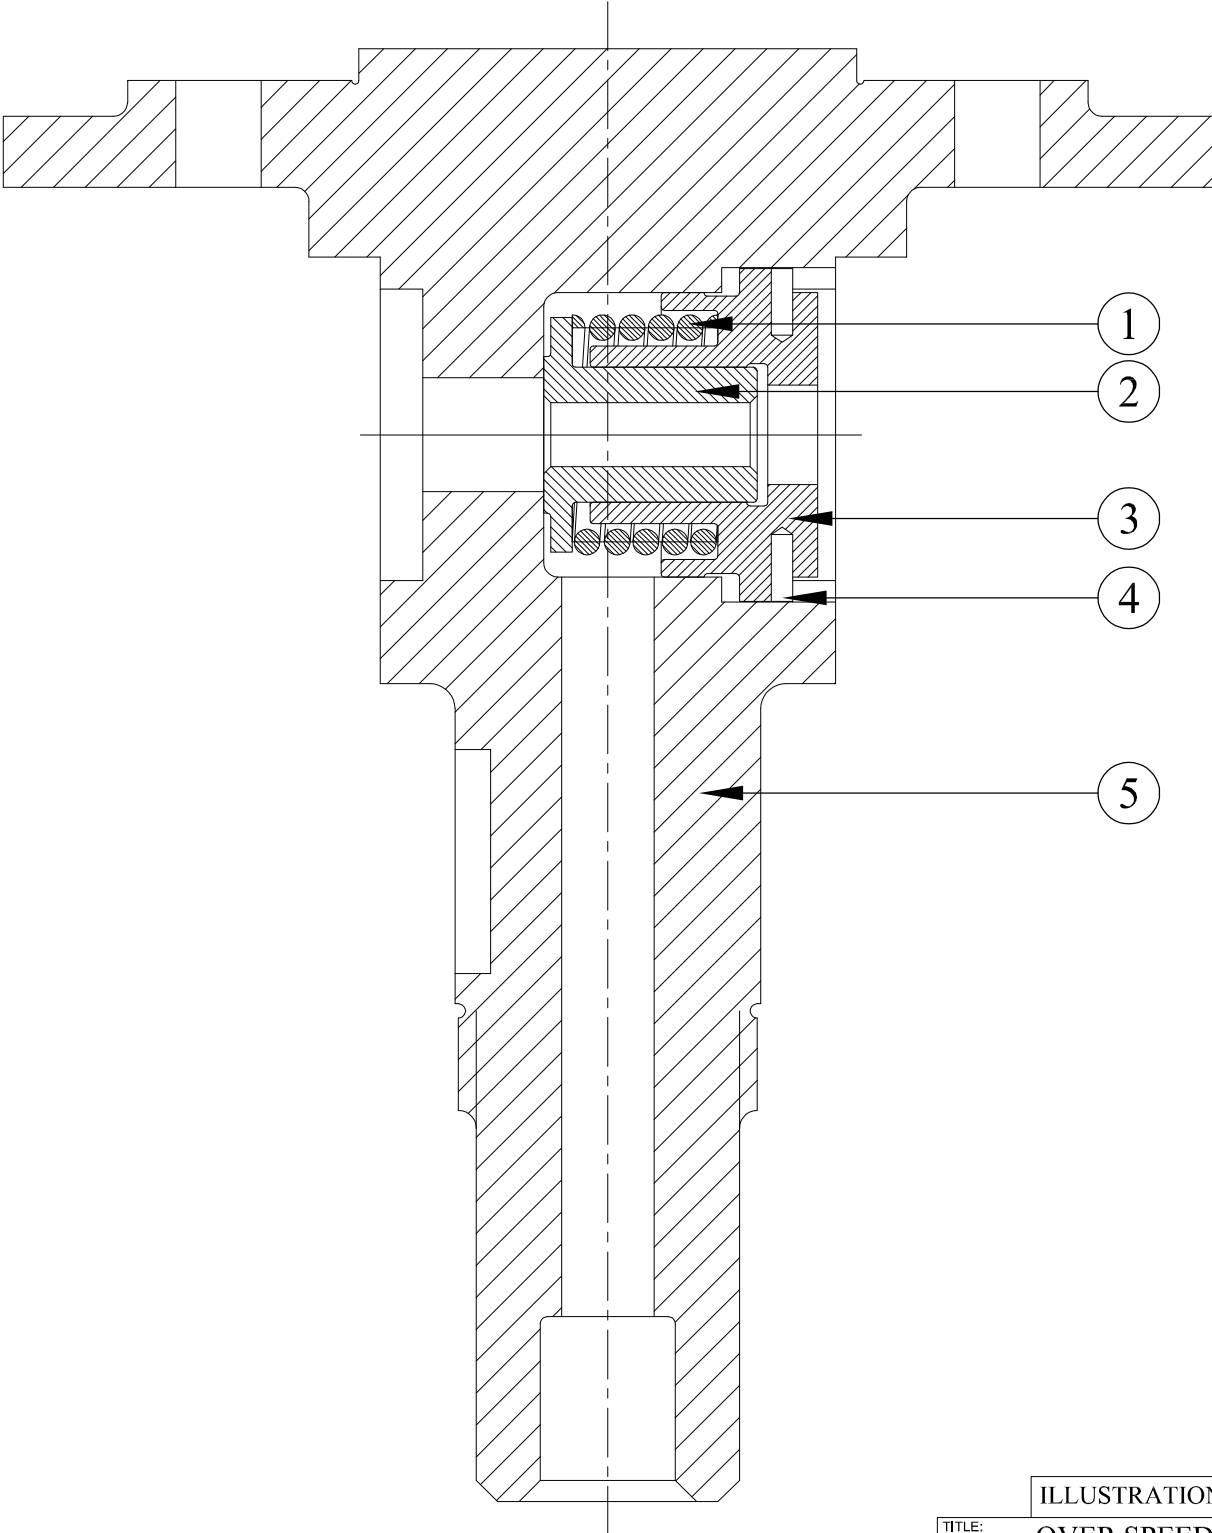


ILLUSTRATION NUMBER-05


TITLE: OVER SPEED TRIP
SHAFT ASSEMBLY

MaxWatt™

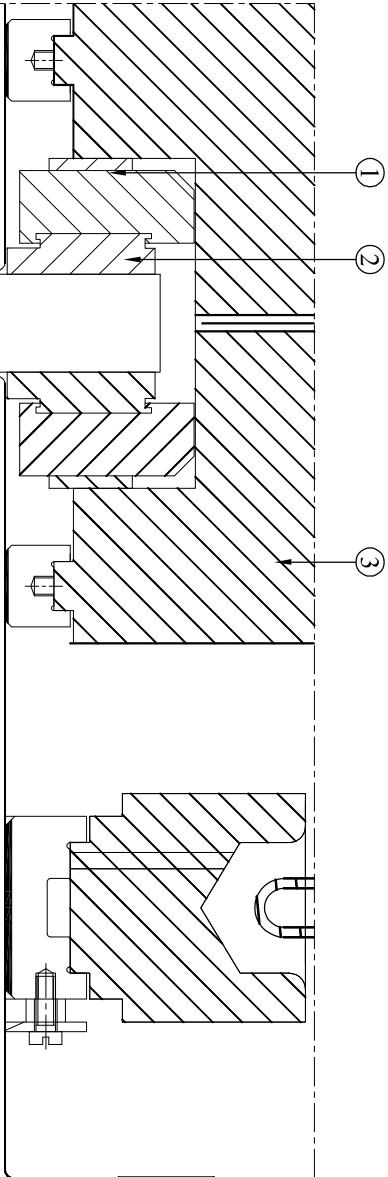DRG. NO.
PT-AS-3500



DESCRIPTION	
ITEM NO.	COMPONENT NAME
1	M5 CSK SCREW
2	THRUST PAD
3	BEARING CAP
4	SPACER RING
5	CARRIER RING
6	PADS HOLDING DOWN SCREW
7	ROTOR SHAFT
8	ROTOR JOURNAL BEARING
9	STEAM END PEDESTAL

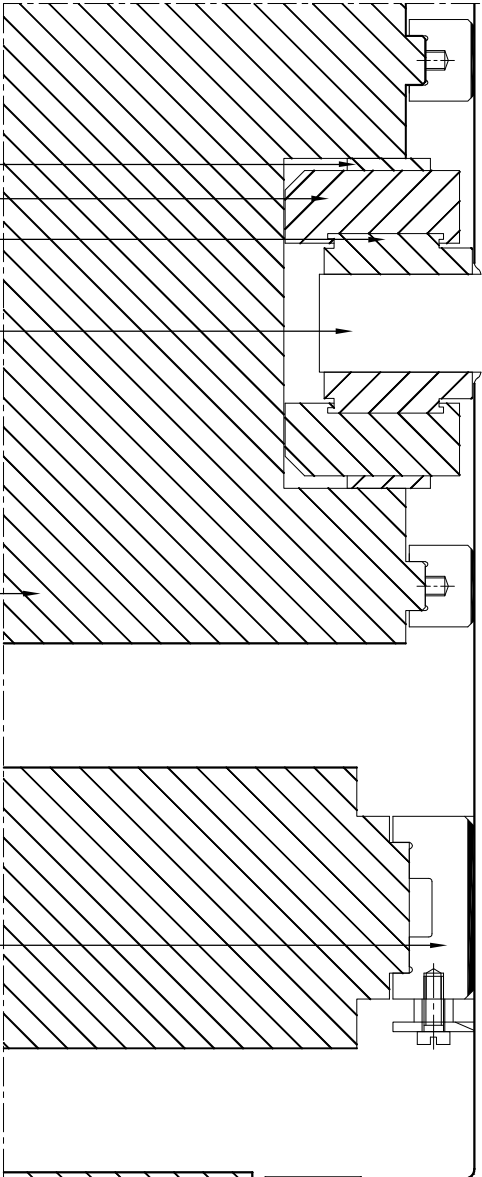


TITLE: JOURNAL & THRUST
BEARING ASSEMBLY

ILLUSTRATION NUMBER-09

MaxWatt™
MAXWATT TURBINES PRIVATE LIMITED

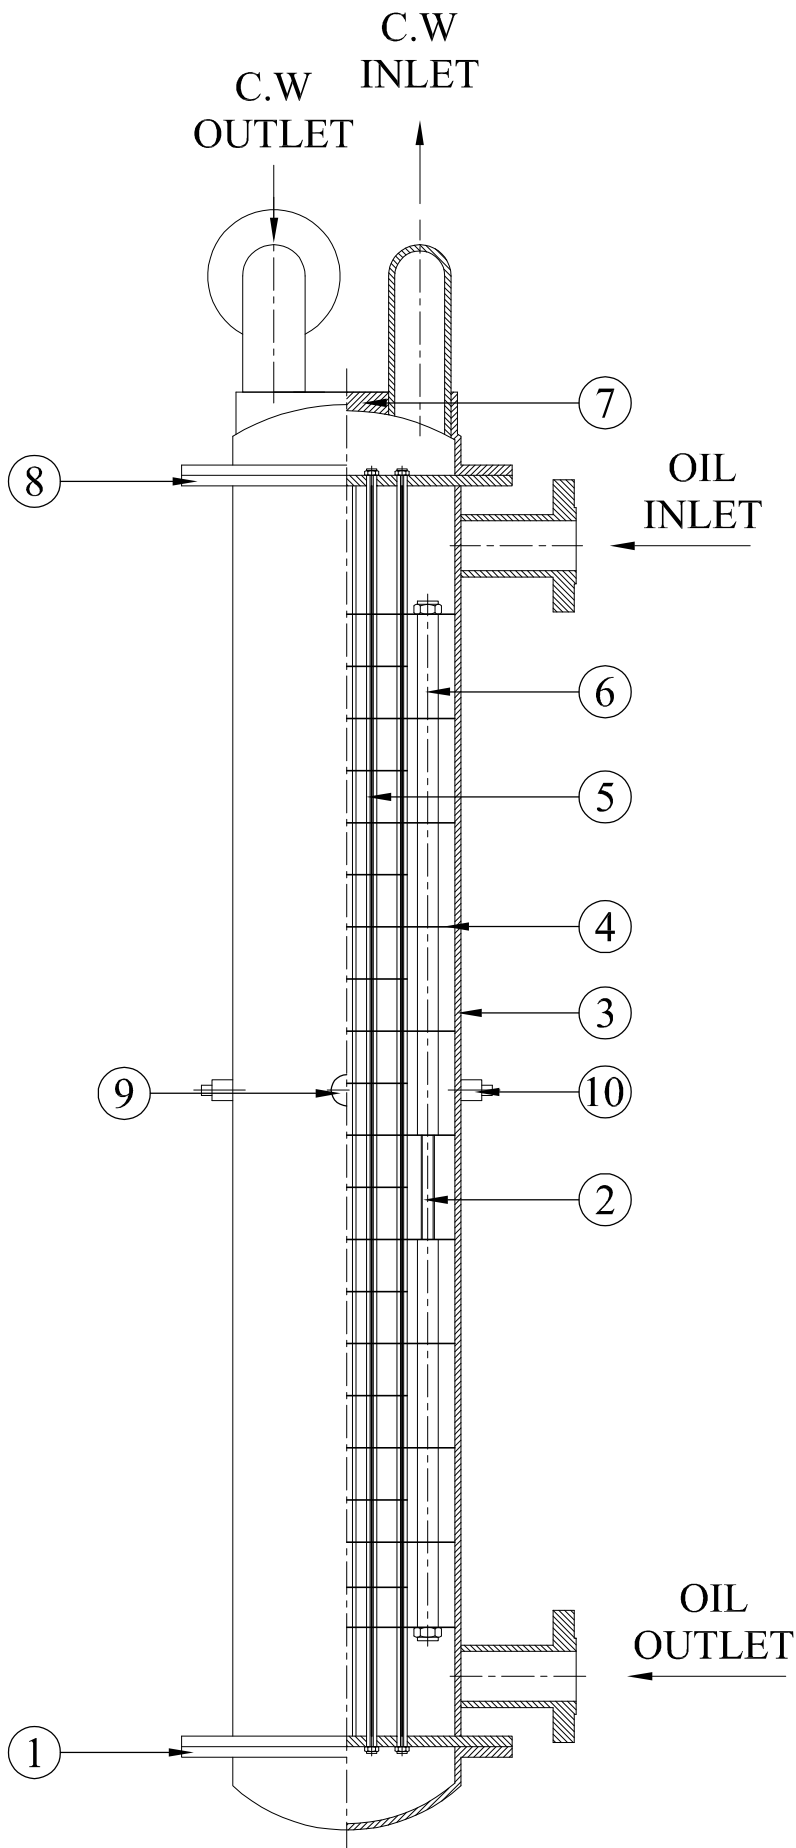DRG. NO.
PT-AS-2307



DESCRIPTION	
ITEM NO	COMPONENT NAME
1	END COVER
2	TIE RODS
3	SHELL
4	BAFFLE PLATES
5	TUBES
6	SPACER
7	C.W IN/OUT END COVER
8	TUBE SHEET
9	SHELL AIR VENT
10	SHELL DRAIN

ILLUSTRATION NUMBER-07

TITLE:

OIL COOLER

Max/Watt™

DRG. NO.
PT-PRA-1135

DESCRIPTION	
ITEM NO	COMPONENT NAME
1	METAL SCREEN
2	FILTER BODY
3	MICROFELT CARTRIDGE
4	LOCKING NUT
5	COVER PLATE
6	OIL SEAL

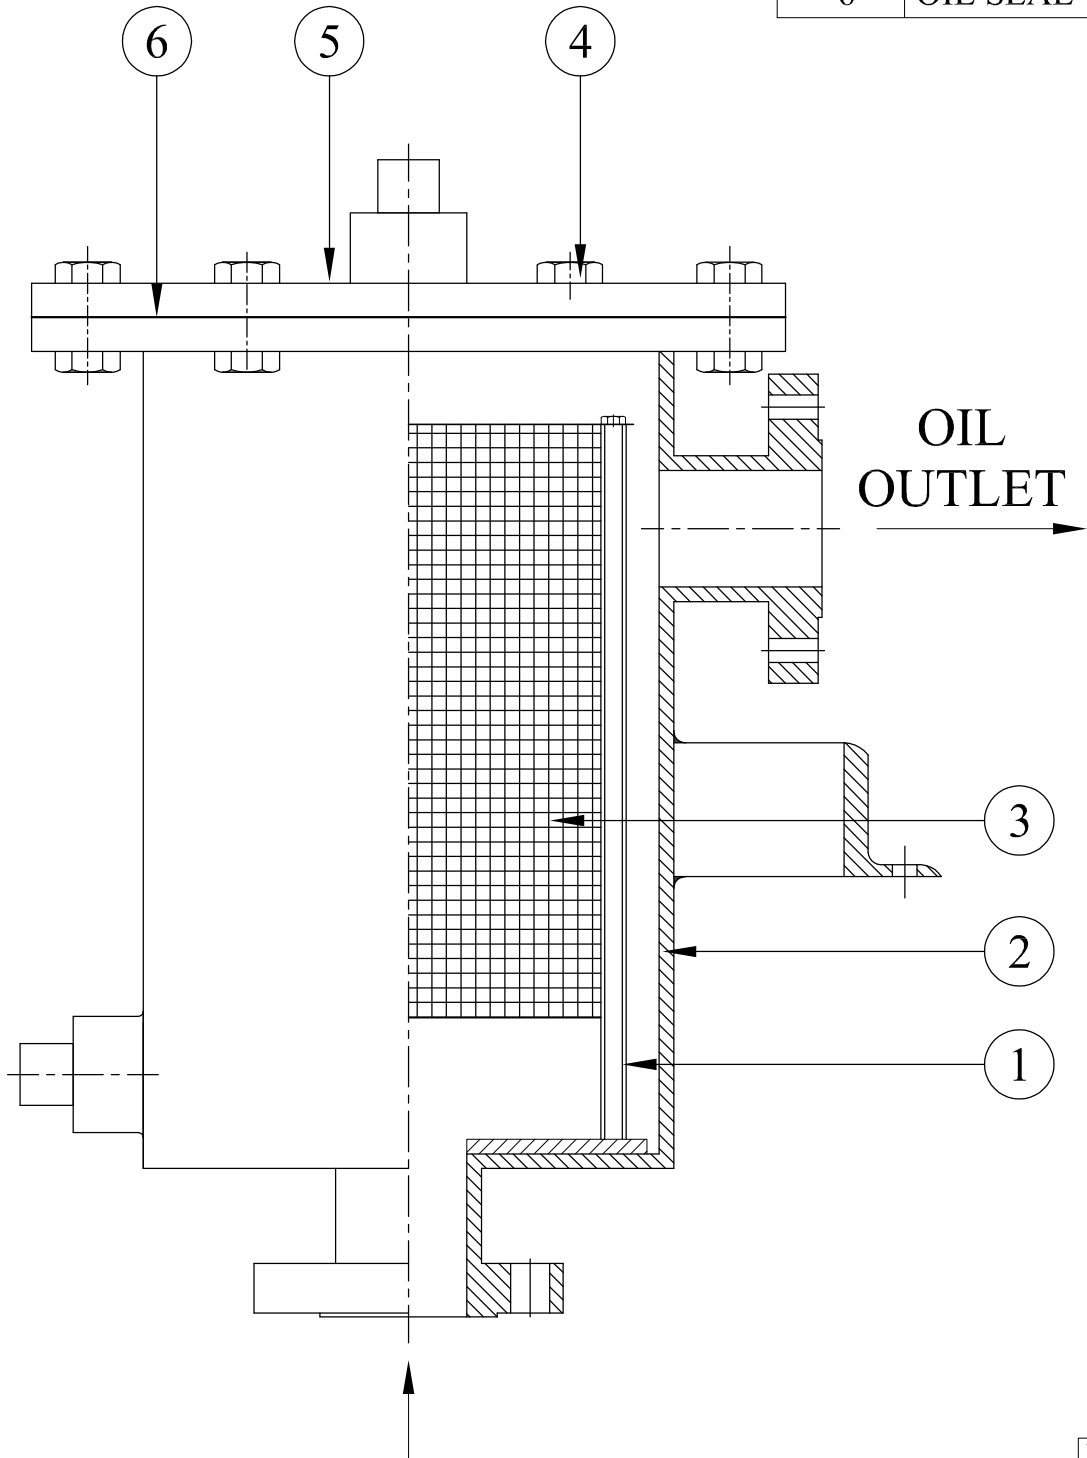


ILLUSTRATION NUMBER-08

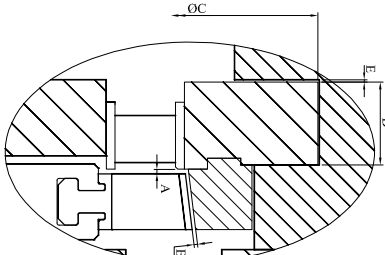
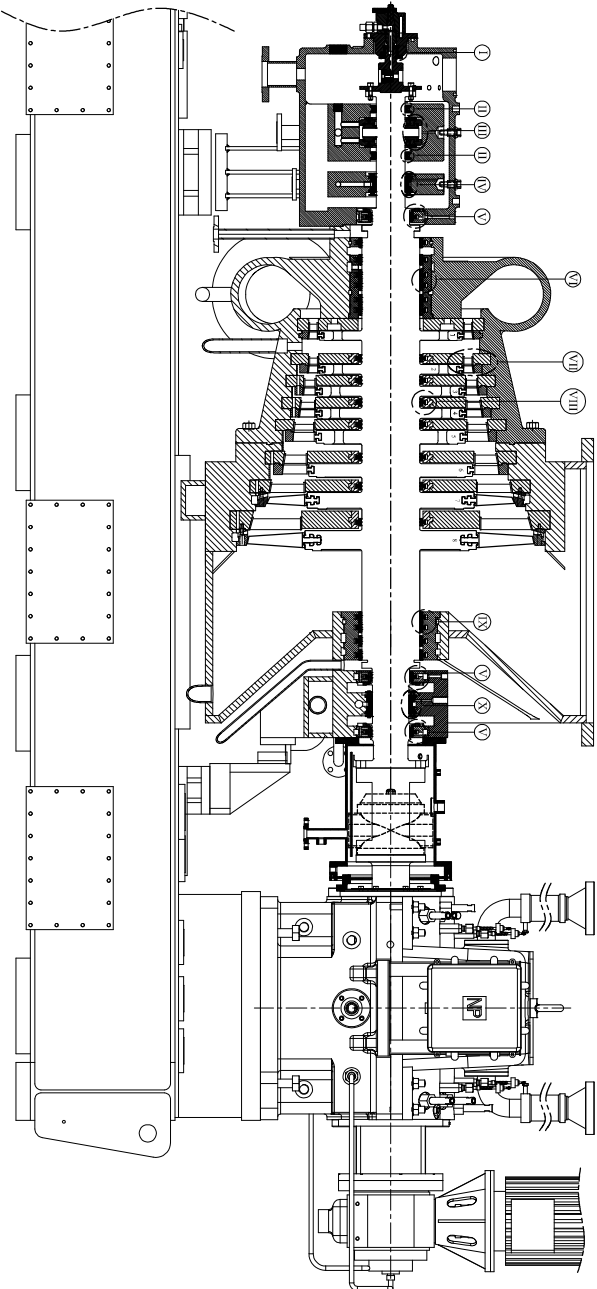
TITLE:

OIL FILTER

MaxWatt™


DRG. NO.

PT-PRA-1134




STAGE	A	B	OC	D	E
1	4.0±0.2	1.0±0.2	0643	42	0.05
2	2.0±0.2	1.5±0.2	0688	38	0.05
3	2.0±0.2	1.5±0.2	0722	38	0.05
4	2.0±0.2	1.5±0.2	0751.5	38	0.05
5	2.0±0.2	2.0±0.2	0796	38	0.05
6	2.0±0.5	2.0±0.2	0867	44	0.05
7	6.6±0.5	2.0±0.2	0972	44	0.05
8	9.0±0.5	2.0±0.2	01109	64	0.05

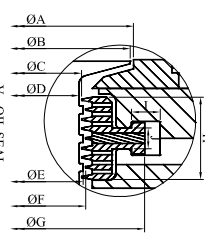VII - DIAPHRAGM BLADE & NOZZLE




Y - OIL SEAL

OA	OB	OC	OD	OE	OF	OG	H	I	J
0169.5	0169	-0.22 0130 ⁺ 0.20	-0.00 0130 ⁺ 0.02	-0.00 0133 ⁺ 0.02	-0.22 0131 ⁺ 0.20	0168	31.5	10	8

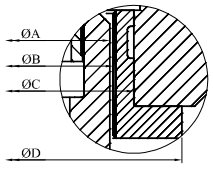


I - SHAFT END BEARING

OA	OB	OC	OD
-0.02 037 ⁺ 0.00	-0.22 037 ⁺ 0.20		050 080

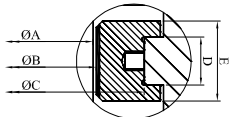


II - OIL SEAL BEARING

OA	OB	OC	D	E
-0.08 0100 ⁺ 0.10	-0.15 0100 ⁺ 0.12	0130	15	25

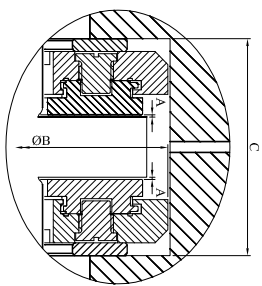


III - THRUST BEARING

A	OB	C
0.12	0216	101

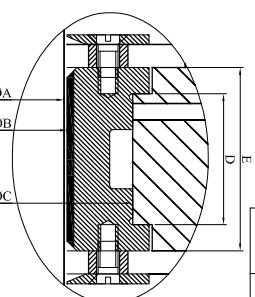


IV - H.P. BEARING

OA	OB	OC	D	E
-0.08 0100 ⁺ 0.10	-0.12 0100 ⁺ 0.10	0140	40	56

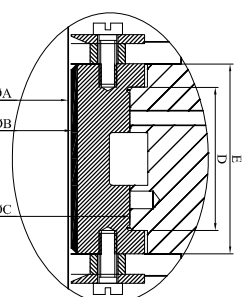


X - L.P. BEARING

OA	OB	OC	D	E
-0.08 0125 ⁺ 0.10	-0.12 0125 ⁺ 0.10	0165	49	65

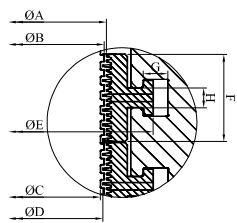


VI - H.P. LABYRINTH

OA	OB	OC	OD	OE	F	G	H
-0.28 0203 ⁺ 0.25	-0.00 0203 ⁺ 0.02	-0.28 0200 ⁺ 0.25	-0.28 0200 ⁺ 0.25	0241	35.5	10	8

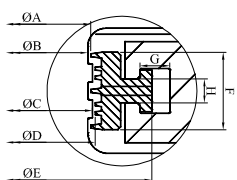

VIII - INTER STAGE LABYRINTH

OA	OB	OC	OD	OE	F	G	H
-0.28 0203 ⁺ 0.25	-0.00 0203 ⁺ 0.02	-0.00 0200 ⁺ 0.25	-0.28 0200 ⁺ 0.25	0241	26	10	8

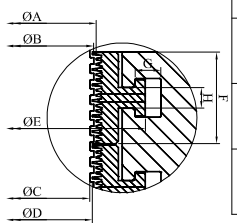

IX - L.P. LABYRINTH

OA	OB	OC	OD	OE	F	G	H
-0.28 0203 ⁺ 0.25	-0.00 0203 ⁺ 0.02	-0.00 0230 ⁺ 0.02	-0.28 0200 ⁺ 0.25	0241	26	10	8

CLEARANCE & FITTING DETAILS

MAXWATT TURBINES PRIVATE LIMITED
9111, BODANASSANBOY, DEKAN LINK ROAD,
BANGALORE, KARNATAKA - 560095

PT-AS-9889

DATE - 15/12/2014


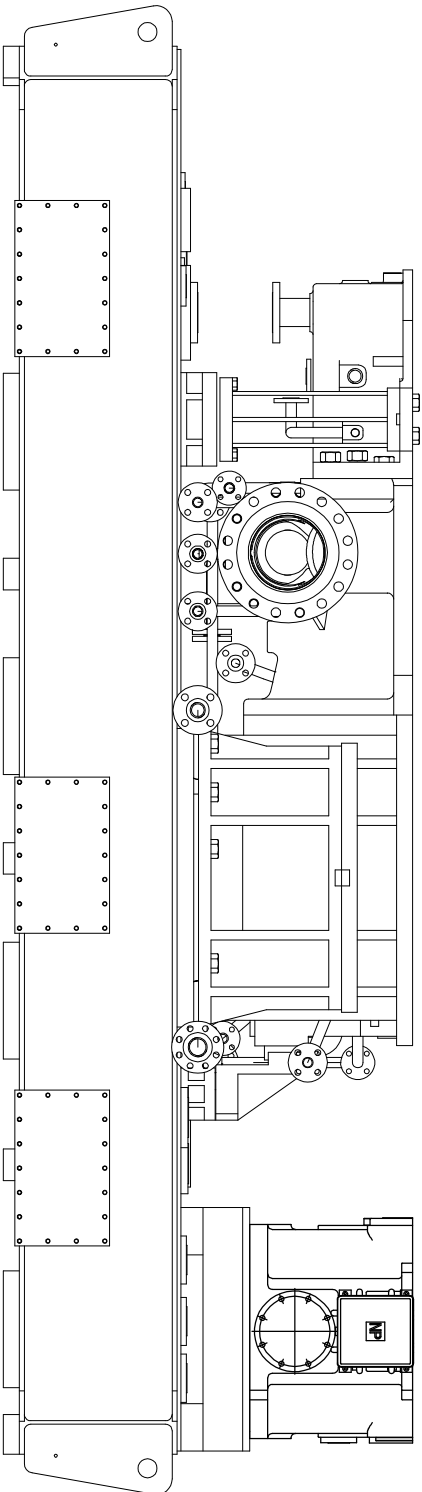
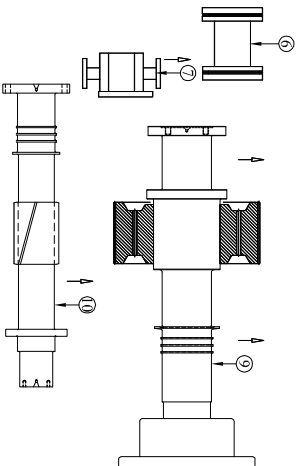
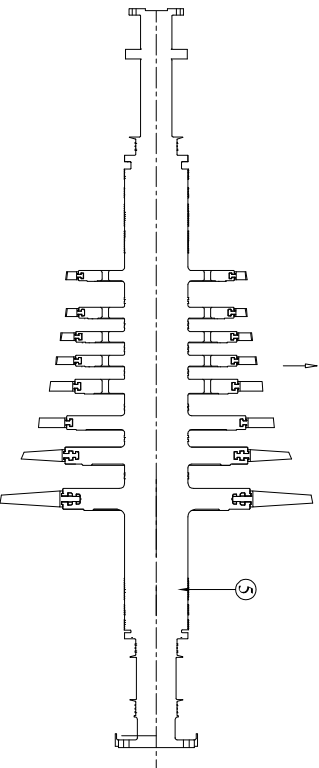
SCALE N.T.S

ILLUSTRATION NUMBER: 3

Drawn By: S.R. B. S. B.

REV 00

DESCRIPTION	
ITEM NO	COMPONENT NAME
1	MANUAL TRIP ASSEMBLY
2	SHAFT END BEARING
3	STEAM END PEDESTAL TOP
4	STEAM & EXHAUST CASING TOP HALF
5	ROTOR ASSEMBLY
6	HIGH SPEED COUPLING
7	MAIN OIL PUMP
8	GEAR BOX TOP COVER
9	GEAR WHEEL & GEAR SHAFT
10	PINION SHAFT

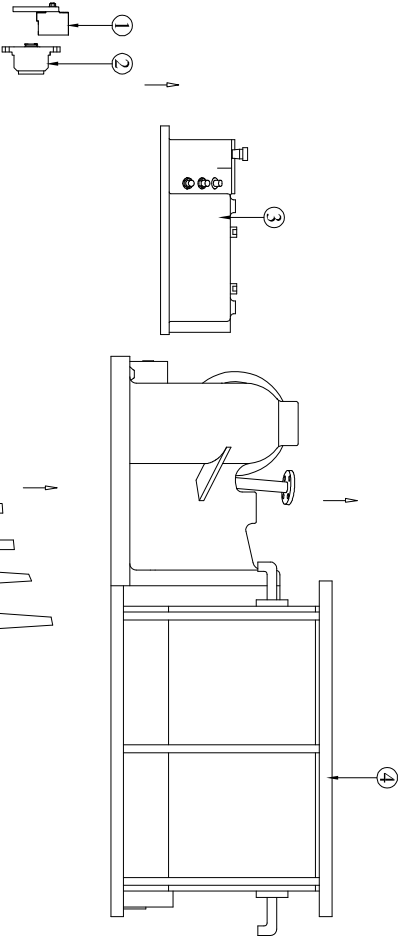



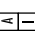

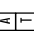




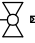








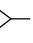

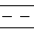





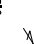

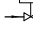
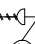
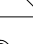


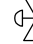

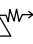

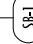


TITLE: LIFTING ARRANGEMENT

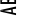





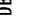













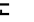



ILLUSTRATION NUMBER-10

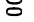

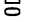
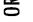
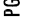

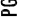

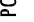
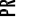
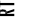
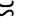
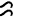
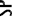
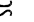
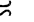
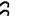

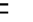


Max/WattTM DRG. No. PT-AS-7969

LEGEND

-  FIELD MOUNTED
-  PANEL MOUNTED
-  TRANSMITTER
-  ALARM
-  ALARM/INTERLOCK
-  INTERLOCK
-  ALARM/TRIP
-  PROGRAMMABLE LOGIC CONTROLLER (PLC)
-  NEEDLE VALVE (NV)
-  GATE VALVE (GV)
-  GLOBE VALVE (GV)
-  BALL VALVE (BV)
-  SOLENOID VALVE (SV)
-  BUTTERFLY VALVE (BV)
-  EXPANSION BELOW (EB)
-  EXPANDER (EXP)
-  CONTROL VALVE (CV)
-  STEAM TRAP (STP)
-  NON RETURN VALVE (NRV)
-  Y STRAINER (YS)
-  DRAIN FUNNEL
-  REDUCER (RED)
-  FLOW NOZZLE (FN)
-  STRAINER (ST)
-  PUMP ASSEMBLY

-  QUICK CLOSING GATE VALVE (QCGTV)
-  FULL FLOW RELIEF VALVE (FFRV)
-  QUICK CLOSING NON RETURN VALVE (QCNRV)
-  THREE WAY VALVE (TWV)
-  THREE WAY THERMOSTATIC CONTROL VALVE
-  RELIEF VALVE
-  VENT
-  RUPTURE DISC
-  TRIP OIL LINE
-  PNEUMATIC LINE
-  STEAM LINE
-  SILENCER
-  DISTRIBUTION BLOCK (OIL DISTRIBUTOR)
-  AIR FILTER REGULATOR
-  ELECTRIC TO PNEUMATIC CONVERTER

-  AB AIR BREATHER
-  AOP AUXILIARY OIL PUMP
-  BV BALL VALVE
-  BGM BARRING GEAR MOTOR
-  COV CHANGE OVER VALVE
-  DPIS DIFFERENTIAL PRESSURE INDICATOR
-  DB DISTRIBUTION BLOCK
-  EOP EMERGENCY SHUTT OFF VALVE
-  ESV EMERGENCY STOP VALVE
-  FT FLOW TRANSMITTER
-  FV FOOT VALVE
-  FH FLEXIBLE HOSE
-  GCV GOVERNOR CONTROL VALVE
-  HOP HAND OIL PUMP
-  JB JUNCTION BOX
-  LIC LEVEL INDICATOR/CONTROLLER
-  LG LEVEL GAUGE
-  LT LEVEL TRANSMITTER
-  LS LEVEL SWITCH
-  LPT LOW PRESSURE TRIP
-  LA LINIER ACTUATOR
-  MPU MAGNETIC PICK UP UNIT
-  OLI OIL LEVEL INDICATOR
-  OR ORIFICE

-  OC OIL COOLER
-  OF OIL FILTER
-  OD OIL DRAIN
-  OR ORIFICE
-  PG PRESSURE GAUGE
-  PS PRESSURE SWITCH
-  PGS PRESSURE GAUGE SWITCH
-  PT PRESSURE TRANSMITTER
-  PCV PRESSURE CONTROL VALVE
-  PRV PRESSURE REDUCING VALVE
-  RTD RESISTANCE TEMPERATURE DETECTOR
-  SC SERVO CYLINDER
-  SS STAINLESS STEEL
-  SPV SPOOL VALVE
-  SC SPEED INDICATOR
-  SC SERVO CYLINDER
-  SSC STEAM SURFACE CONDENSER
-  TI TEMPERATURE INDICATOR
-  TT TEMPERATURE TRANSMITTER
-  TI TEMPERATURE INDICATOR
-  ZS LIMIT SWITCH

CUSTOMER : GREEN ENERGY GROUP

CONSULTANT : VERKS

SITE : KERYA

MODEL : GCM

DRIVEN EQUIPMENT : GENERATOR (TPDS)

GENERATOR RATING : 5.5MW

TITLE: LEGEND FOR P&Id

MaxWatt™

MAXWATT TURBINES PRIVATE LIMITED
113, 115, 117, 997, 999

Drawn by: Pushpa

Checked by: Prasanna

Appd by: Prasanna

DES. NO. PT-LGD-GC5M

DATE : 19/08/2013

REV 00

SCALE NTS

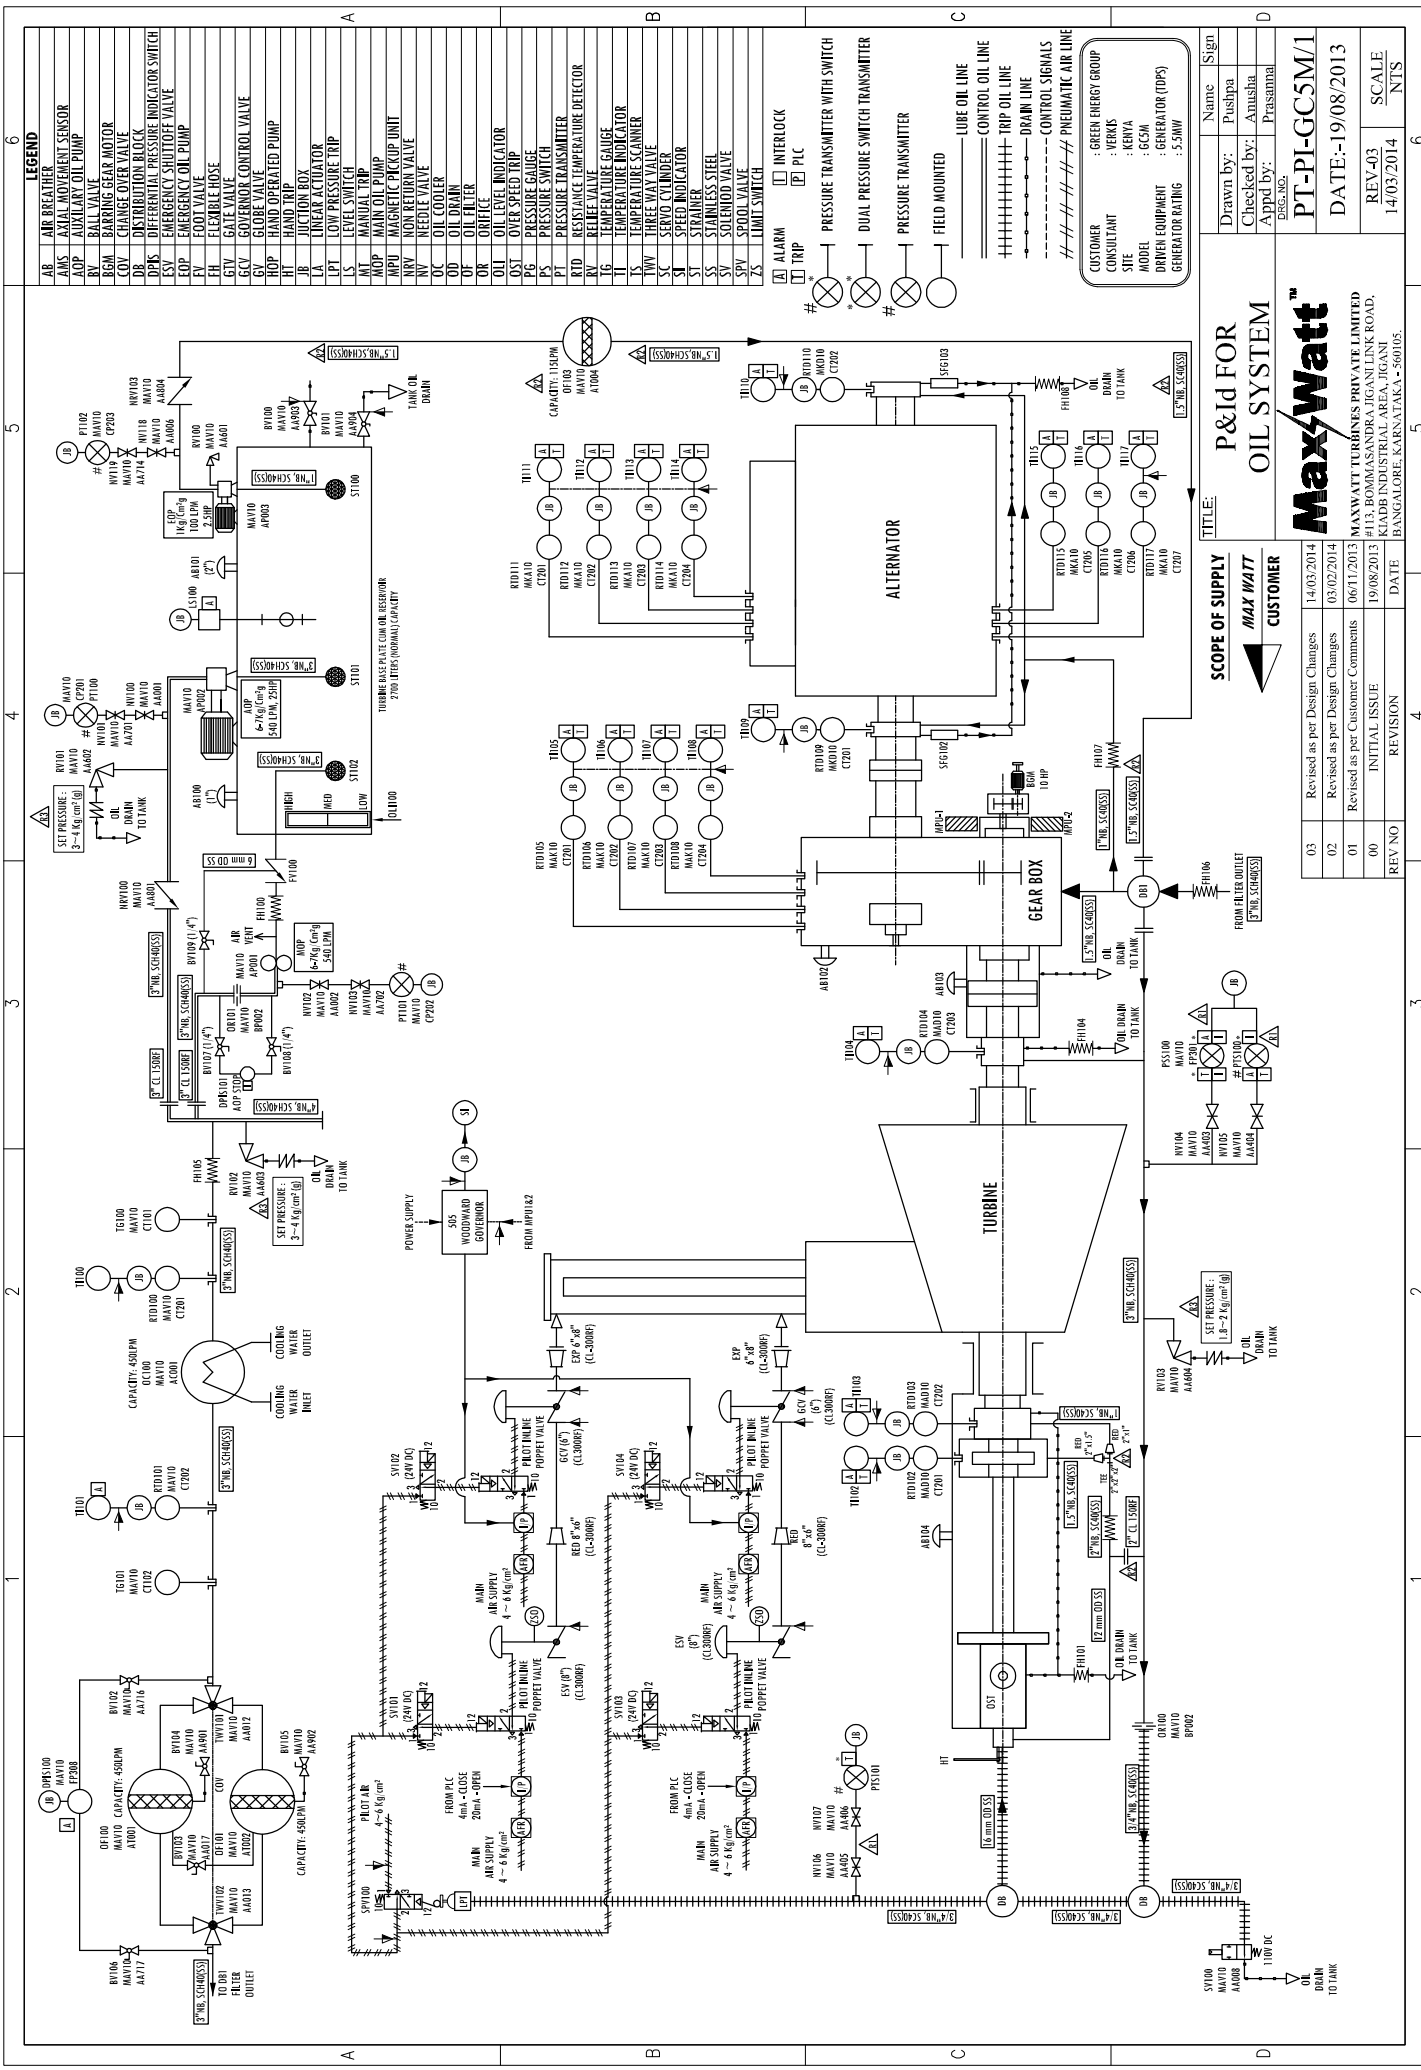
SCOPE OF SUPPLY

MAX WATT
CUSTOMER

INITIAL ISSUE
REVISION

19/08/2013
DATE

MAXWATT TURBINES PRIVATE LIMITED
113, 115, 117, 997, 999



SCOPE OF SUPPLY		P&ID FOR OIL SYSTEM	
03	Revised as per Design Changes	14-03-2014	Max Watt
02	Revised as per Design Changes	03-02-2014	Max Watt
01	Revised as per Customer Comments	06-11-2013	Max Watt
00	INITIAL ISSUE	19-08-2013	Max Watt
REV NO	REVISION	DATE	CUSTOMER

TITLE:		P&ID FOR OIL SYSTEM	
Max Watt		Max Watt	
PT-PI-GC5M/1		Max Watt	
DATE:-19/08/2013		Max Watt	
REV-03		Max Watt	
14/03/2014		Max Watt	
NTS		Max Watt	

SCOPE OF SUPPLY		P&ID FOR OIL SYSTEM	
03	Revised as per Design Changes	14-03-2014	Max Watt
02	Revised as per Design Changes	03-02-2014	Max Watt
01	Revised as per Customer Comments	06-11-2013	Max Watt
00	INITIAL ISSUE	19-08-2013	Max Watt
REV NO	REVISION	DATE	CUSTOMER

SCOPE OF SUPPLY		P&ID FOR OIL SYSTEM	
03	Revised as per Design Changes	14-03-2014	Max Watt
02	Revised as per Design Changes	03-02-2014	Max Watt
01	Revised as per Customer Comments	06-11-2013	Max Watt
00	INITIAL ISSUE	19-08-2013	Max Watt
REV NO	REVISION	DATE	CUSTOMER

SCOPE OF SUPPLY		P&ID FOR OIL SYSTEM	
03	Revised as per Design Changes	14-03-2014	Max Watt
02	Revised as per Design Changes	03-02-2014	Max Watt
01	Revised as per Customer Comments	06-11-2013	Max Watt
00	INITIAL ISSUE	19-08-2013	Max Watt
REV NO	REVISION	DATE	CUSTOMER

SCOPE OF SUPPLY		P&ID FOR OIL SYSTEM	
03	Revised as per Design Changes	14-03-2014	Max Watt
02	Revised as per Design Changes	03-02-2014	Max Watt
01	Revised as per Customer Comments	06-11-2013	Max Watt
00	INITIAL ISSUE	19-08-2013	Max Watt
REV NO	REVISION	DATE	CUSTOMER

SCOPE OF SUPPLY		P&ID FOR OIL SYSTEM	
03	Revised as per Design Changes	14-03-2014	Max Watt
02	Revised as per Design Changes	03-02-2014	Max Watt
01	Revised as per Customer Comments	06-11-2013	Max Watt
00	INITIAL ISSUE	19-08-2013	Max Watt
REV NO	REVISION	DATE	CUSTOMER

